


PLAN  
SCALE: 1" = 30'

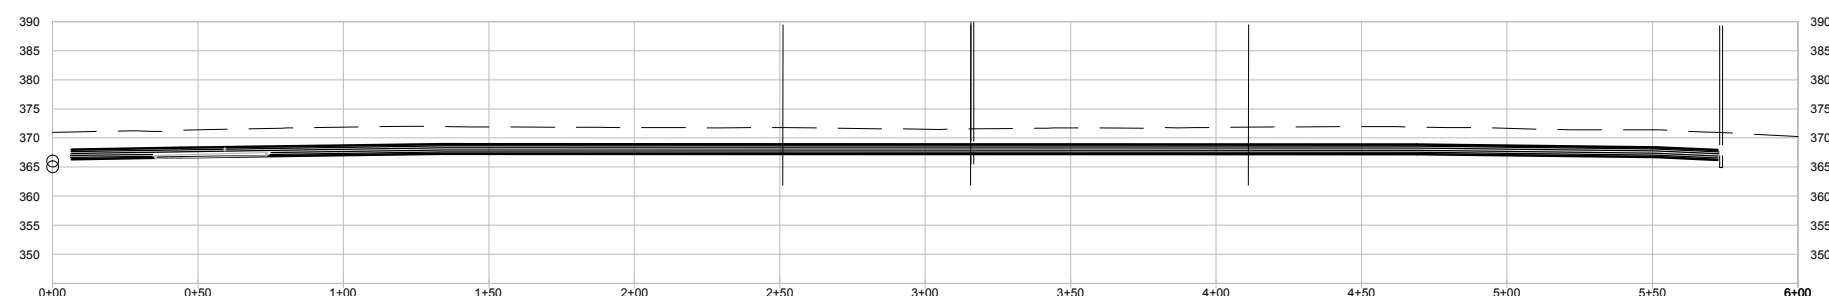

ELECTRICAL DUCT BANK PROFILE  
HORZ SCALE: 1" = 30'  
VERT SCALE: 1" = 15'

DRAFT FOR REVIEW

**SURVEY NOTES:**

1. TOPOGRAPHIC INFORMATION BASED ON SURVEY PERFORMED BY FISHER ASSOCIATES DATED FEBRUARY 27, 2014.
2. COORDINATES, ELEVATIONS AND NORTH ORIENTATION SHOWN HEREON ARE REFERENCED TO FACILITY SPECIFIC SYSTEM. BASED ON A DRAWING ENTITLED "EXISTING SITE PLAN" HAVING FILE NUMBER 00659, PREPARED BY ENVIRONMENTAL ENGINEERING ASSOCIATES, LLP, AND DATED APRIL 2001.
3. UNDERGROUND UTILITIES SHOWN HEREON WERE PLOTTED FROM FIELD LOCATIONS. VISIBLE AT THE TIME OF SURVEY. THE LOCATIONS OF ALL UNDERGROUND RECORD INFORMATION UTILITIES (REC) SHOULD BE STAKED BY THE RESPECTIVE UTILITY COMPANY PRIOR TO ANY CONSTRUCTION.

**REFERENCES:**

1. AS-BUILT MAP ENTITLED "HAWATHA PIPELINE BY O'BRIEN & GERE FOR THE ONONDAGA COUNTY WATER AUTHORITY DATED APRIL 8, 1959.
2. A BOUNDARY MAP BY BRYANT ASSOCIATES, P.C. DATED JUNE 24, 2005

SCALE VERIFICATION: THIS BAR MEASURES 1" ON ORIGINAL. ADJUST SCALE ACCORDINGLY.

No.	Revision	Date	Initial

WARNING: ALTERING THIS DOCUMENT IS IN VIOLATION OF THE NEW YORK STATE EDUCATION LAW EXCEPTING AS PROVIDED IN SECTION 7209, PART 2 OF THE LAW.

ONONDAGA COUNTY DEPARTMENT OF WATER ENVIRONMENT PROTECTION  
METROPOLITAN SYRACUSE WWTP  
SECONDARY BYPASS DISINFECTION IMPROVEMENTS  
  
ELECTRICAL DUCT BANK  
PROPOSED EASEMENT

<b>CRA Infrastructure &amp; Engineering, Inc.</b>		Date: FEBRUARY 2014	
Source Reference: <small>2014 MAP INFORMATION: TOPOGRAPHICAL SURVEY BY FISHER ASSOCIATES, ROCHESTER, NEW YORK, DATE: JANUARY 29, 2014 FOR PROJECT AREA. ELECTRONIC RECORD DRAWINGS FROM ENVIRONMENTAL ENGINEERING ASSOCIATES, LLP, DATED APRIL 2001 USED FOR LOCATION PURPOSES ONLY.</small>	Project Manager: C. MARTIN	Reviewed By: C. COWAN	Designed By: C. COWAN
Scale: HORZ SCALE: 1" = 30' VERT SCALE: 1" = 15'	Project No: 631010-00	Report No: MISC001	Drawn By: S. PIKE
Drawing No: NG-01		Date: FEBRUARY 2014	